

FEEDER SCHEDULE (COPPER)		
FEEDER TAG	FEEDER SIZE	
15.3, 20.3	3#12, #12G, 3/4"	
15.4, 20.4	4#12, #12G, 3/4"	
30.3	3#10, #10G, 3/4"	
30.4	4#10, #10G, 3/4"	
40.3	3#8, #10G, 3/4"	
40.4	4#8, #10G, 3/4"	
50.3	3#6, #10G, 3/4"	
50.4	4#6, #10G, 1"	
60.3	3#4, #10G, 1"	
60.4	4#4, #10G, 1-1/4"	
70.3	3#4, #8G, 1"	
70.4	4#4, #8G, 1-1/2"	
80.3	3#3, #8G, 1-1/4"	
80.4	4#3, #8G, 1-1/4"	
90.3	3#2, #8G, 1-1/4"	
90.4	4#2, #8G, 1-1/4"	
100.3	3#1, #8G, 1-1/4"	
100.4	4#1, #8G, 1-1/2"	
110.3	3#1, #8G, 1-1/4"	
110.4	4#1, #8G, 1-1/2"	
125.3, 150.3	3#10, #6G, 1-1/2"	
125.4, 150.4	4#10, #6G, 2"	
175.3	3#20, #6G, 2"	
175.4	4#20, #6G, 2"	
200.3	3#30, #6G, 2"	
200.4	4#30, #6G, 2"	
225.3	3#40, #4G, 2"	
225.4	4#40, #4G, 2-1/2"	
250.3	3#250, #4G, 2-1/2"	
250.4	4#250, #4G, 2-1/2"	
300.3	3#350, #4G, 2-1/2"	
300.4	4#350, #4G, 3"	
350.3	3#500, #3G, 3"	
350.4	4#500, #3G, 3-1/2"	
400.3	2 SETS OF 3#30, #3G, 2"	
400.4	2 SETS OF 4#30, #3G, 2-1/2"	
500.3	2 SETS OF 3#250, #2G, 2-1/2"	
500.4	2 SETS OF 4#250, #2G, 2-1/2"	
600.3	2 SETS OF 3#350, #1G, 2-1/2"	
600.4	2 SETS OF 4#350, #1G, 2-1/2"	
700.3	2 SETS OF 3#10, #2G, 3"	
700.4	2 SETS OF 4#500, #10G, 3-1/2"	
800.3	2 SETS OF 3#600, #10G, 3-1/2"	
800.4	2 SETS OF 4#600, #10G, 4"	
1000.3	3 SETS OF 3#500, #20G, 3"	
1000.4	3 SETS OF 4#500, #20G, 3"	
1200.3	4 SETS OF 3#350, #30G, 3"	
1200.4	4 SETS OF 4#350, #30G, 3-1/2"	
1600.3	5 SETS OF 3#500, #40G, 3"	
1600.4	5 SETS OF 4#500, #40G, 3"	
2000.3	6 SETS OF 3#500, #40G, 3"	
2000.4	6 SETS OF 4#500, #40G, 3"	
2500.3	7 SETS OF 3#500, #40G, 3-1/2"	
2500.4	7 SETS OF 4#500, #40G, 3-1/2"	
3000.3	8 SETS OF 3#500, #40G, 3"	
3000.4	8 SETS OF 4#500, #40G, 3-1/2"	
3200.3	8 SETS OF 3#600, #40G, 4"	
3200.4	8 SETS OF 4#600, #40G, 4"	
4000.3	10 SETS OF 3#600, #40G, 4"	
4000.4	10 SETS OF 4#600, #40G, 4"	

NOTES:

- BASED ON 30C AMBIENT AND 75C CONDUCTORS. RESIZE FEEDER PER NEC FOR OTHER AMBIENT TEMPERATURES.
- ALL FEEDERS SHALL BE THHN/THWN-2 COPPER, UNLESS NOTED OTHERWISE.
- BRANCH CIRCUITS DO NOT ACCOUNT FOR VOLTAGE DROP.
- BASED ON 3 CURRENT CARRYING CONDUCTORS IN RACEWAY.

BRANCH CIRCUIT WIRING SCHEDULE			
BREAKER		WIRE SIZE	
AMPERAGE	POLE		
20A	1P	2#12, #12G, 3/4"	
20A	2P	3#12, #12G, 3/4"	
20A	3P	4#12, #12G, 3/4"	
30A	1P	2#10, #10G, 3/4"	
30A	2P	3#10, #10G, 3/4"	
30A	3P	4#10, #10G, 3/4"	
40A	1P	2#8, #10G, 3/4"	
40A	2P	3#8, #10G, 3/4"	
40A	3P	4#8, #10G, 1"	
50A	2P	3#6, #10G, 1"	
50A	3P	4#6, #10G, 1-1/2"	
60A	2P	3#6, #10G, 1"	
60A	3P	4#6, #10G, 1-1/2"	
70A	2P	3#4, #8G, 1-1/2"	
70A	3P	4#4, #8G, 1-1/2"	
80A	2P	3#4, #8G, 1-1/2"	
80A	3P	4#4, #8G, 1-1/2"	
100A	2P	3#3, #8G, 1-1/2"	
100A	3P	4#3, #8G, 1-1/2"	

NOTES:

- BASED ON 30C AMBIENT AND 75C CONDUCTORS. RESIZE FEEDER PER NEC FOR OTHER AMBIENT TEMPERATURES.
- ALL FEEDERS SHALL BE THHN/THWN-2 COPPER, UNLESS NOTED OTHERWISE.
- BRANCH CIRCUITS DO NOT ACCOUNT FOR VOLTAGE DROP.
- BASED ON 3 CURRENT CARRYING CONDUCTORS IN RACEWAY.

ELECTRICAL LEGEND	
	MANUAL FIRE PULL STATION
	AREA SMOKE DETECTOR, CEILING MOUNTED
	AREA SMOKE DETECTOR, WALL MOUNTED
	SMOKE DETECTOR, MOUNTED IN DUCT
	HEAT DETECTOR, CEILING MOUNTED
	SPRINKLER WATER FLOW SWITCH
	SPRINKLER TAMPER SWITCH
	AUDIBLE FIRE ALARM STROBE, CEILING MOUNTED
	AUDIBLE FIRE ALARM STROBE, WALL MOUNTED
	AUDIO/VISUAL FIRE ALARM STROBE, CEILING MOUNTED
	AUDIO/VISUAL FIRE ALARM STROBE WALL MOUNTED
	VISUAL FIRE ALARM STROBE, CEILING MOUNTED
	VISUAL FIRE ALARM STROBE, WALL MOUNTED
	FIREMAN'S JACK
	FIRE ALARM BELL
	FIRE/SMOKE DAMPER
	SMOKE DAMPER
	FIRE ALARM CONTROL PANEL
	FIRE ALARM REMOTE ANNUNCIATOR PANEL
	SIMPLEX RECEPTACLE, WALL MOUNTED
	DUPLEX RECEPTACLE, WALL MOUNTED
	DUPLEX RECEPTACLE, CEILING MOUNTED
	DUPLEX RECEPTACLE, TOP HALF SWITCHED
	QUADRUPLX RECEPTACLE, WALL MOUNTED
	SPECIAL PURPOSE RECEPTACLE, WALL MOUNTED, COORDINATE NEMA PLUG TYPE WITH OWNER
	DUPLEX RECEPTACLE, GROUND FAULT INTERRUPTER
	DUPLEX RECEPTACLE, ISOLATED GROUND
	DUPLEX RECEPTACLE, WEATHERPROOF
	COMBINATION POWER/TELECOM FLOOR BOX OR FIRE RATED POKE THRU DEVICE, REFER TO PLANS FOR SPECIFICATION
	TELECOM OUTLET. PROVIDE BACK BOX/COVER PLATE. INSTALL 3/4" WBUSHING AND PULLSTRING, STUBBED TO ACCESSIBLE CEILING.
	TELEVISION OUTLET. PROVIDE BACK BOX/COVER PLATE. INSTALL 3/4" WBUSHING AND PULLSTRING, STUBBED TO ACCESSIBLE CEILING.
	SINGLE POLE SWITCH
	DOUBLE POLE SWITCH
	THREE WAY SWITCH
	FOUR WAY SWITCH
	KEY LOCKED SWITCH
	MOMENTARY CONTACT SWITCH
	TIMER SWITCH
	WALL DIMMER
	LOW VOLTAGE SWITCH
	OCCUPANCY SENSOR SWITCH
	VACANCY SENSOR SWITCH
	PHOTOCCELL
	VACANCY OR OCCUPANCY SENSOR SWITCH WATTSTOPPER DW-100 SERIES
	VS
	CEILING MOUNTED VACANCY OR OCCUPANCY SENSOR WATTSTOPPER DT-300 SERIES
	OS

ELECTRICAL LEGEND	
	SURFACE MOUNTED PANEL
	PANEL RECESSED IN WALL
	STEP DOWN TRANSFORMER
	GROUND BUS BAR
	HEAVY DUTY DISCONNECT SWITCH
	HEAVY DUTY FUSED DISCONNECT SWITCH
	COMBINATION MOTOR STARTER/DISCONNECT SWITCH
	VFD WITH DISCONNECT, COORDINATE WITH MECHANICAL CONTRACTOR
	EMERGENCY POWER OFF SWITCH
	MOTORIZED SHADE CONTROL
	THERMAL OVERLOAD SWITCH
	MOTOR CONNECTION, HP AS NOTED
	SINGLE PHASE MOTOR CONNECTION, HP AS NOTED
	JUNCTION BOX, CEILING MOUNTED
	JUNCTION BOX, WALL MOUNTED
	PULL BOX
	GROUND ROD
	GROUND WELL
	CIRCUIT BREAKER
	SWITCH AND FUSE
	ENCLOSED CIRCUIT BREAKER
	NORMALLY OPEN CONTACT
	NORMALLY CLOSED CONTACT
	NUMBERED NOTE
	EXIT SIGN; WALL MOUNTED
	EXIT SIGN; CEILING MOUNTED
	FIXED CLOSED CIRCUIT CAMERA
	MOTION SENSOR
	MAGNETIC LOCK
	KEYPAD
	DOOR RELEASE
	PUSH BUTTON
	CARD READER
	ELECTRIC LOCK
	ELECTRIC STRIKE
	CONDUIT CONCEALED IN CEILING OR WALL
	CONDUIT BELOW FLOOR OR IN SLAB
	CONDUIT STUBBED OUT AND CAPPED W/PULLSTRING
	CONDUIT HOMERUN BACK TO PANEL

ELECTRICAL ABBREVIATIONS	
(E)EXIST	EXISTING
(N)	NEW
(R)RELOC	EXISTING TO BE RELOCATED
A	AMPERES
AV	AUDIO/VISUAL
AF	AMPERE FUSE RATING
AFF	ABOVE FINISHED FLOOR
AFG	ABOVE FINISHED GRADE
AIC	AMPERES INTERRUPTING CAPACITY
AL	ALUMINUM
AT	AMPERE TRIP RATING
ATS	AUTOMATIC TRANSFER SWITCH
BKR	BREAKER
BLDG	BUILDING
C	CONDUIT
CCTV	CLOSED CIRCUIT TELEVISION
CKT	CIRCUIT
CM	CEILING MOUNTED
CU	COPPER
DIA	DIAMETER
DPDT	DOUBLE POLE DOUBLE THROW
ELEC	ELECTRICAL
EMT	ELECTRICAL METALLIC TUBING
EP	EXPLOSION PROOF
FAAP	FIRE ALARM ANNUNCIATOR PANEL
FACP	FIRE ALARM CONTROL PANEL
FWE	FURNISHED WITH EQUIPMENT
GC	GENERAL CONTRACTOR
GF/GFCI	GROUND FAULT CIRCUIT INTERRUPTER
GND	GROUND
HP	HORSEPOWER
IG	ISOLATED GROUND
KVA	KILO-VOLT AMPERE
KW	KILO-WATT
LTG	LIGHTING
MCB	MAIN CIRCUIT BREAKER
MCC	MOTOR CONTROL CENTER
MDP	MAIN DISTRIBUTION PANEL
MLO	MAIN LUGS ONLY
MTD	MOUNTED
MTS	MANUAL TRANSFER SWITCH
NC	NORMALLY CLOSED
NEUT	NEUTRAL
NIC	NOT IN CONTRACT
NO	NORMALLY OPEN
NTS	NOT TO SCALE
PB	PULL BOX
PNL	PANEL
PVC	POLYVINYL CHLORIDE CONDUIT
SH	SHIELDED
SWBD	SWITCHBOARD
SWGR	SWITCHGEAR
TC	TIME CLOCK
TS	TIME SWITCH
TVSS	TRANSIENT VOLTAGE SURGE SUPPRESSOR
TYP	TYPICAL
UNON	UNLESS OTHERWISE NOTED
UPS	UNINTERRUPTABLE POWER SUPPLY
V	VOLT
WP	WEATHERPROOF

ELECTRICAL SHEET LIST	
SHEET NUMBER	SHEET NAME
E0.01	ELECTRICAL COVER SHEET
E0.02	ELECTRICAL SPECIFICATIONS
E2.01	POWER PLAN
E3.01	LIGHTING PLAN
E5.01	ELECTRICAL DETAILS
E6.01	PLUMBING DETAILS

CODE SUMMARY	
1.	APPLICABLE CODES INCLUDE BUT ARE NOT LIMITED TO:
A.	NATIONAL ELECTRICAL CODE (2020 NEC) WITH LOCAL AMENDMENTS.
B.	INTERNATIONAL BLDG CODE 2015.
C.	LIFE SAFETY CODE (NFPA 101).
D.	ENERGY CONSERVATION CODE: ASHRAE 90.1 – 2013 OR IECC 2015.
E.	REFER TO BUILDING OWNER FOR ANY STANDARDS ABOVE CODE REQUIREMENT.



Date Issued:
02/23/24
06/26/24


Issue for Construction
IFC Set Addendum 02



10200 Westheimer Road., Suite 400
Houston, TX 77042
713-429-4949
www.InfinityMEP.com

HUCK FINN SOLAR
OPERATIONS & MAINTENANCE BUILDING

Project Address:
 (39.322039, -91.541742) Vandalia, MO

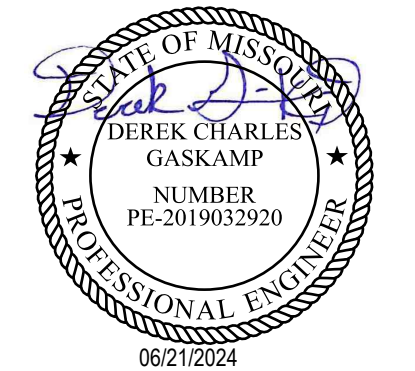

Copyright 2022
MBA Energy & Industrial
Drawings and Specifications are instruments of service and shall remain the property of MBA Energy & Industrial. They are not to be used on other projects or extensions to this project except by agreement in writing and with appropriate compensation to MBA Energy & Industrial.

Sheet Content:
ELECTRICAL COVER SHEET

SCALE: NOT TO SCALE

Drawn By:
Checked By:
Plot Date: 01/29/2024
Project Number: H23233

Sheet:

E0.01

KEYNOTES	
KEYNOTE	DESCRIPTION
1	PROVIDE J-BOX FOR MOTORIZED GATE. COORDINATE EXACT REQUIREMENTS AND LOCATION WITH VENDOR.
2	PROVIDE 120V POWER FOR SEPTIC SYSTEM.



Date Issued:
02/23/24
06/26/24


Issue for Construction
IFC Set Addendum 02




10200 Westheimer Road., Suite 400
Houston, Tx 77042
713-429-4949
www.InfinityMEP.com

**HUCK FINN SOLAR
OPERATIONS & MAINTENANCE BUILDING**

Project Address:
(39.322039, -91.541742) Vandalia, MO

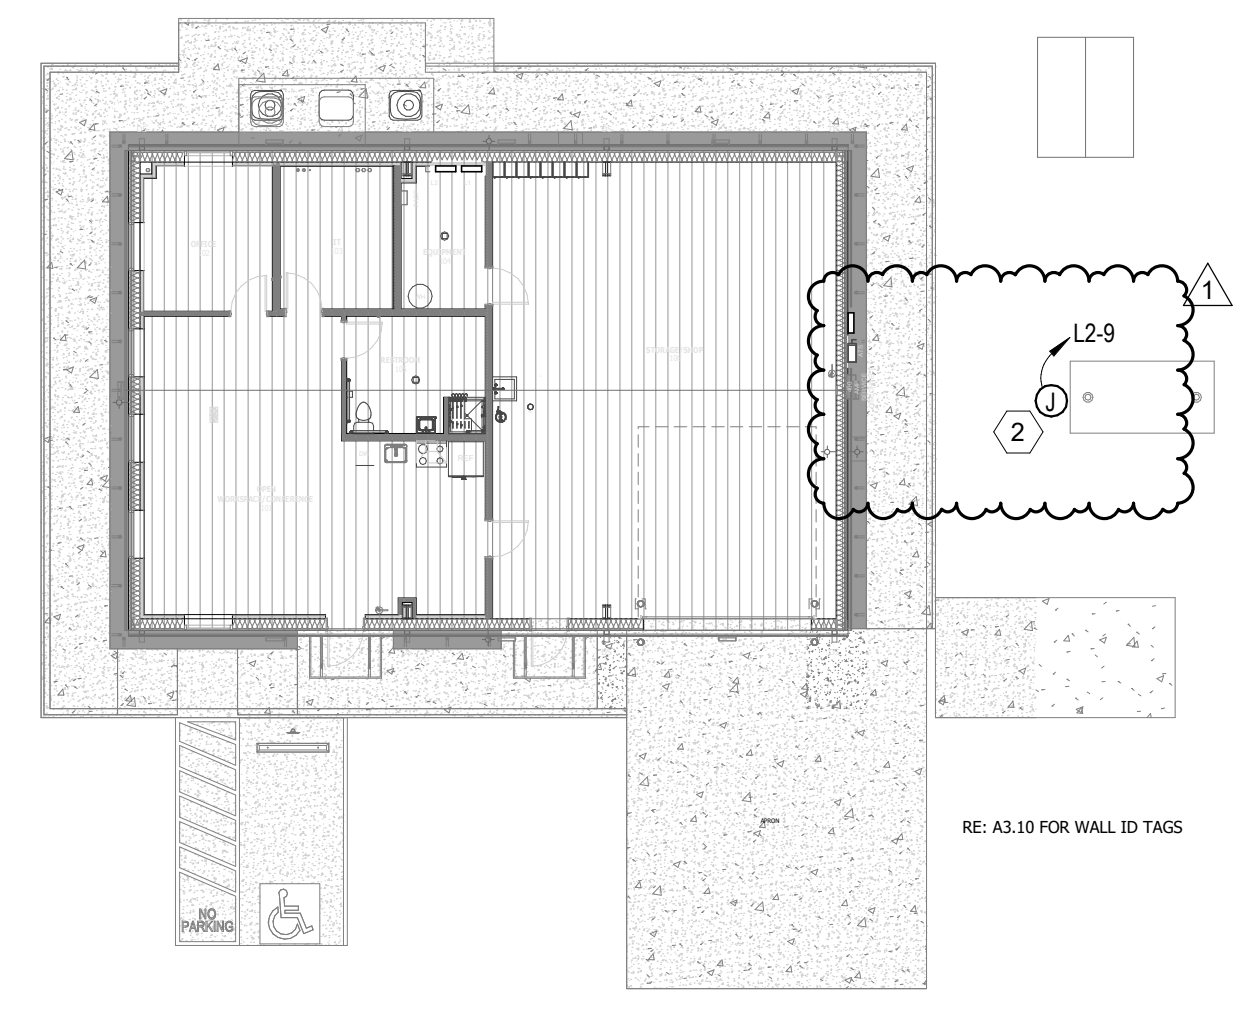


① ② L2-5.7

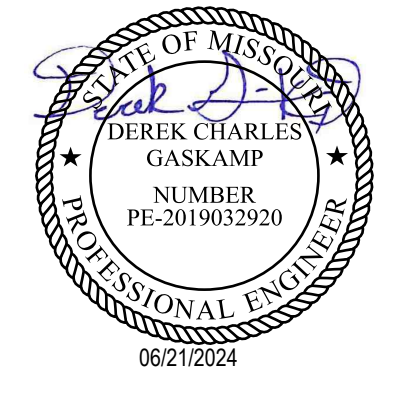

Copyright 2022
MBA Energy & Industrial
Drawings and Specifications are instruments of service and shall remain the property of MBA Energy & Industrial. They are not to be used on other projects or extensions to this project except by agreement in writing and with appropriate compensation to MBA Energy & Industrial.

Sheet Content:
ELECTRICAL SITE PLAN

SCALE: 1/16" = 1'-0"

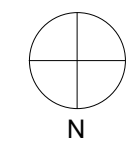

Drawn By: Author
Checked By: Checker
Plot Date: 01/27/22
Project Number: H23233

Sheet:

E0.50

1 ELECTRICAL SITE PLAN
1/16" = 1'-0"

FIRE ALARM NOTES	
A	FIRE ALARM SYSTEM DESIGN (DEVICES AND LAYOUT) ARE UNDER SEPARATE PERMIT BY THE FIRE ALARM CONTRACTOR.
B	FIRE ALARM SYSTEM CONSTRUCTION DOCUMENTS FOR THE SCOPE OF WORK INDICATED IN THIS PROJECT SHALL BE SUBMITTED TO THE LOCAL AUTHORITY HAVING JURISDICTION FOR APPROVAL PRIOR TO COMMENCING FIRE ALARM WORK AND THE INSTALLATION MUST BE APPROVED BY THE LOCAL AUTHORITY HAVING JURISDICTION AFTER COMPLETION.
D	THE FIRE ALARM SYSTEM MODIFICATIONS FOR THIS PROJECT SHALL BE DESIGNED BY A LICENSED FIRE ALARM CONTRACTOR AND BE IN ACCORDANCE WITH NFPA 72 & 101 AND THE LOCAL AUTHORITY HAVING JURISDICTION BUILDING CODE. CONTRACTOR IS RESPONSIBLE FOR SUBMISSION OF PL.
E	ALL 120V CIRCUITS REQUIRED FOR THE OPERATION OF THE FIRE ALARM SYSTEM SHALL BE INCLUDED. LOCATIONS OF ALL PANELS AND BOOSTERS SHALL BE COORDINATED WITH ARCHITECT. CONTRACTOR SHALL TEST THE SYSTEM IN THE PRESENCE OF LOCAL AUTHORITIES AND MAKE ALL REQUIRED MODIFICATIONS AND ADDITIONS TO THE DESIGN AT NO ADDITIONAL COST.
F	FIRE ALARM NOTIFIER SHALL REPORT TO LOCAL FIRE DEPARTMENT AND TO THE AMEREN CORPORATE MONITORING SYSTEM.

GENERAL NOTES	
B	REFER TO ARCHITECTURAL DRAWINGS FOR EXACT LOCATION AND MOUNTING HEIGHTS OF ALL DEVICES. REFER TO IT REPRESENTATIVE FOR EXACT LOCATION OF IT DEVICES. REFER TO AV DRAWINGS FOR A DETAILED LAYOUT OF CONDUIT AND CABLE FOR AV DEVICES.
C	PROVIDE RECESSED CLOCK TYPE BOX FOR ALL WALL MOUNTED TV POWER AND AV DEVICES.
E	ALL 125-VOLT THROUGH 250-VOLT RECEPTACLES SUPPLIED BY SINGLE-PHASE BRANCH CIRCUITS RATED 150 VOLTS OR LESS TO GROUND, 50 AMPERES OR LESS, INSTALLED IN THE LOCATIONS SPECIFIED IN 210.8(B) (1) THROUGH (B) (12) SHALL HAVE GROUND FAULT CIRCUIT-INTERRUPTER PROTECTION FOR PERSONNEL. 210.8(B)(2) KITCHENS OR AREAS WITH A SINK AND PROVISIONS FOR EITHER FOOD PREPARATION OR COOKING.

KEYNOTES	
KEYNOTE	DESCRIPTION
1	COORDINATE EXACT APPLIANCE REQUIREMENTS WITH VENDOR.
2	120V POWER FOR HOOD CONTROLS. COORDINATE EXACT LOCATION WITH EQUIPMENT INSTALLER. PROVIDE CONTROL CONTACTORS AND TOGGLE SWITCH AS REQUIRED FOR HOOD CONTROL OF EXHAUST AND SUPPLY FANS.
3	CONTRACTOR TO PROVIDE ELECTRICITY FOR CARD READER WITH MAG LOCK. MAG LOCK TO BE TIED TO FIRE ALARM. PROVIDE MOTION DETECTOR, PUSH RELEASE BUTTON, KEYPAD, ETC AS REQUIRED. COORDINATE WITH BUILDING SECURITY EQUIPMENT. PROVIDE J-BOX AND 3/4" W PULLSTRING STUBBED TO ACCESSIBLE CEILING FOR CARD READER AND PUSH RELEASE BUTTON.
4	COORDINATE ALL REQUIREMENTS IN THIS ROOM WITH TENANT'S IT REPRESENTATIVE.
5	PROVIDE NEW TIME SWITCH 'T1' INTERMATIC #ET2815C. COORDINATE EXACT LOCATION WITH BUILDING ENGINEER.
7	DISCONNECT SHALL BE 60A/240V/2P/N3R/NF.
8	DISCONNECT SHALL BE 30A/240V/2P/N3R/NF.
9	DISCONNECT SHALL BE 30A/240V/2P/N1/NF.
11	PROVIDE J-BOX FOR EV CHARGER.
12	PROVIDE COPPER TELECOMMUNICATIONS GROUNDING BUSBAR. PROVIDE #6 GREEN INSULATED WIRE FROM BUSBAR TO PANEL 'L1' GROUND BAR. COORDINATE ALL REQUIREMENTS AND LOCATION WITH TENANT IT REP.
13	PROVIDE NFPA 780 COMPLIANT LIGHTNING PROTECTION SYSTEM FOR STRUCTURE.
14	3/4" X 10'-0" COPPERCLAD GROUND ROD WITH #4/0 COPPER GROUNDING ELECTRODE CONDUCTOR.
15	PROVIDE RECESSED FLOOR BOX FOR CONFERENCE ROOM. FLOOR BOX SHALL BE HUBBELL #CFB630CR OR EQUIVALENT AND COVER PLATE TO MATCH FLOOR TYPE. PROVIDE 1-1/2" WIPULLSTRING FOR DATA AND 3/4" FOR POWER IN SLAB TO NEAREST WALL AND STUB TO ACCESSIBLE CEILING. COORDINATE FLOOR BOX ACCESSORIES WITH AV REP. COORDINATE FINISH AND LOCATION WITH ARCHITECT.
16	PROVIDE 120V POWER FOR LOUVER MOTORIZED DAMPER. INTERLOCK DAMPER WITH ASSOCIATED MECHANICAL EQUIPMENT.



Date Issued:
02/23/24
06/26/24



Issue for Construction
IFC Set Addendum 02



10260 Westheimer Road., Suite 400
Houston, TX 77042
713-429-4949
www.InfinityMEP.com

HUCK FINN SOLAR
OPERATIONS & MAINTENANCE BUILDING


Project Address:
(39.322039, -91.541742) Vandalia, MO

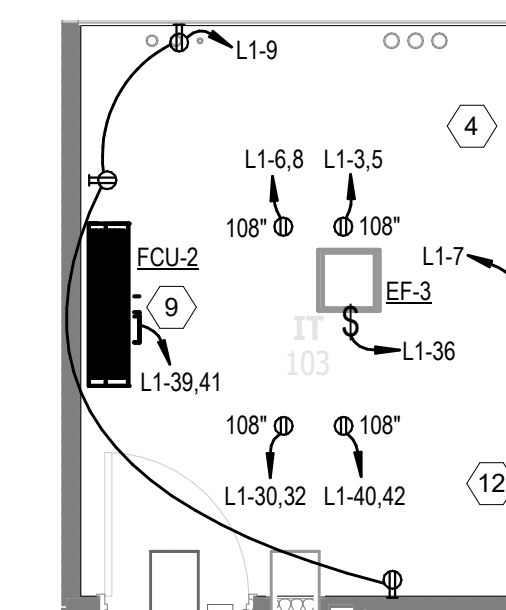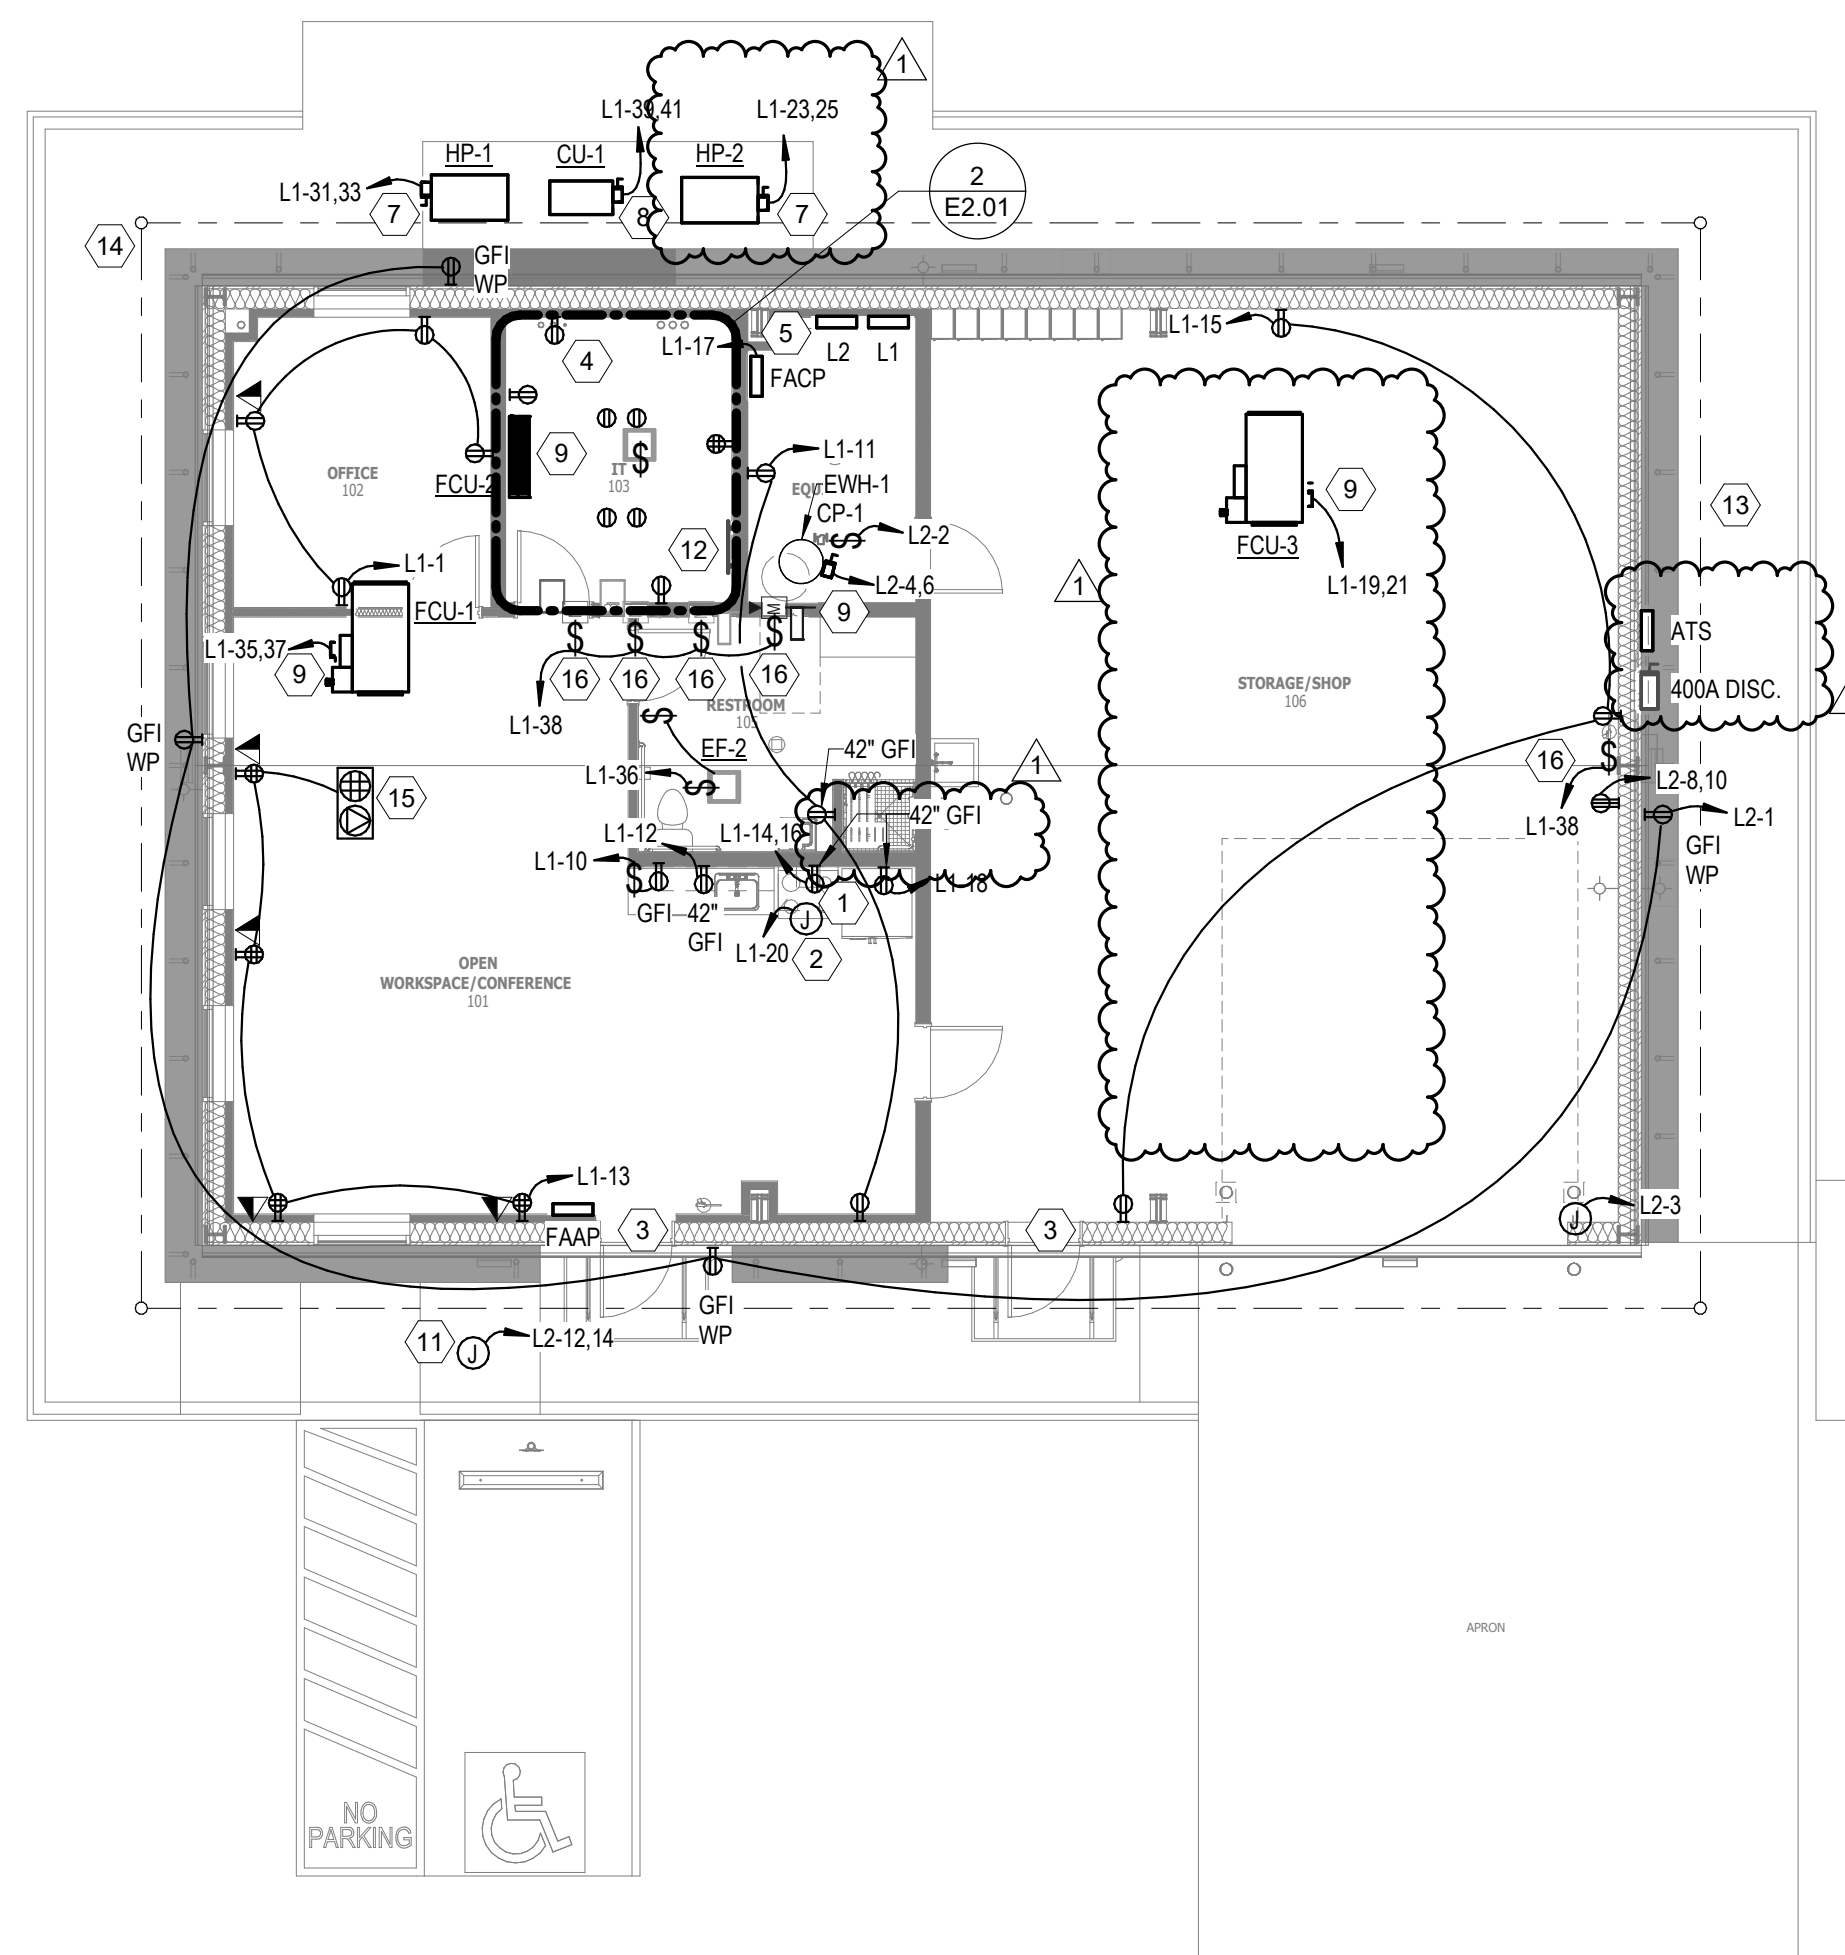

2 ENLARGED IT ROOM
1/4" = 1'-0"

1 POWER PLAN
1/8" = 1'-0"

RE: A3.10

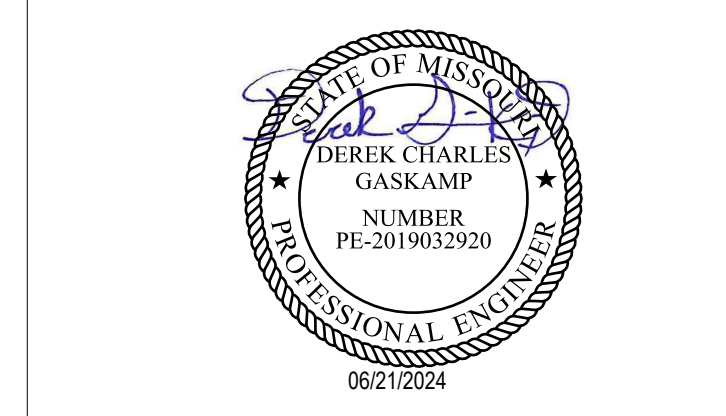

Copyright 2022
MBA Energy & Industrial
Drawings and Specifications are instruments of service and shall remain the property of MBA Energy & Industrial. They are not to be used on other projects or extensions to this project, except by agreement in writing and with appropriate compensation to MBA Energy & Industrial.

Sheet Content:
POWER PLAN

SCALE: As indicated

Drawn By:
Checked By:
Plot Date: 01/29/2024
Project Number: H23233

Sheet:
E2.01

LIGHT FIXTURE SCHEDULE

DESIGNATION	FIXTURE DESCRIPTION	MOUNTING	MANUFACTURER	MODEL NUMBER	LAMP TYPE	DIMMING TYPE	VOLTAGE
A	2X4 RECESSED ARCHITECTURAL LAY-IN	RECESSED	NATIONAL LED	FTR3-24-UNVL-32-SCCT	50W LED	0-10V	UNV
AE	2X4 RECESSED ARCHITECTURAL LAY-IN WITH 90 MIN. EMERGENCY BACKUP BATTERY	RECESSED	NATIONAL LED	FTR3-24-UNVL-32-SCCT-EM	50W LED	0-10V	UNV
B	RECESSED DOWNLIGHT	RECESSED	NATIONAL LED	LTR4-6R-UNV-1-SCCT-WH	13W LED	0-10V	UNV
BE	RECESSED DOWNLIGHT WITH 90 MIN. EMERGENCY BACKUP BATTERY	RECESSED	NATIONAL LED	LTR4-6R-UNV-1-SCCT-WH-EM	13W LED	0-10V	UNV
EM	EXTERIOR EMERGENCY ONLY WALL PACK	SURFACE/WALL	CHLORIDE	PLEMBZ	5W LED		UNV
H	HIGH BAY	RECESSED	NATIONAL LED	EBXLE1-1-UNVL-45-40-C-Y-N	101W LED	0-10V	UNV
HE	HIGH BAY WITH 90 MIN. EMERGENCY BACKUP BATTERY	RECESSED	NATIONAL LED	EBXLE1-1-UNVL-45-40-C-Y-Y	101W LED	0-10V	UNV
W	WALL PACK	SURFACE/WALL	NATIONAL LED	DS-402U-3-UNVL50-BZ	39.9W LED		UNV
X	EXIT SIGN	SURFACE/WALL	CHLORIDE	CLXNRW	5W LED		UNV

GENERAL NOTES


A	REFER TO ARCHITECTURAL DRAWINGS FOR EXACT LOCATION AND MOUNTING HEIGHTS OF FIXTURES.
B	FIXTURES WITH BATTERY PACK SHALL HAVE NORMAL BALLAST CONNECTED TO LIGHT SWITCH, AND BATTERY BALLAST CONNECTED TO UN-SWITCHED POWER. BATTERY BALLAST IS SWITCHED AT PANEL ONLY. REFER TO MANUFACTURER WIRING DIAGRAM FOR INSTALLATION WITH FIXTURE NORMAL BALLAST.
C	EXIT SIGNS SHALL BE CONNECTED TO UN-SWITCHED POWER. EMERGENCY LIGHTS SHALL BE SWITCHED AT PANEL ONLY.
D	GANG ALL LIGHT SWITCHES TOGETHER WHERE POSSIBLE.
E	CONTRACTOR TO PROVIDE TESTING AND COMMISSIONING OF THE LIGHTING CONTROL SYSTEMS IN SCOPE IN ACCORDANCE WITH 2015 IECC SECTION C408. CONTRACTOR SHALL INCLUDE IN BID THE SERVICES OF A REGISTERED DESIGN PROFESSIONAL TO PRODUCE A COMMISSIONING PLAN TO CONFIRM TESTING AND CALIBRATION HAVE BEEN PERFORMED IN ACCORDANCE WITH THE CONSTRUCTION DOCUMENTS. COPIES OF ALL DOCUMENTATION SHALL BE GIVEN TO THE OWNER OR OWNER'S AUTHORIZED AGENT WITHIN 90 DAYS OF RECEIPT OF CERTIFICATE OF OCCUPANCY AND MADE AVAILABLE TO CODE OFFICIAL UPON REQUEST IN ACCORDANCE WITH SECTIONS C408.3.1.1 AND C408.3.1.2.

KEYNOTES


KEYNOTE	DESCRIPTION
1	HOMERUN EXTERIOR LIGHTS VIA PHOTOCELL. COORDINATE EXACT LOCATION AND SCHEDULES WITH OWNER/ARCHITECT. PHOTOCELL SHALL BE INTERMATIC #EK4238S OR EQUIVALENT.

HUCK FINN SOLAR OPERATIONS & MAINTENANCE BUILDING

Project Address:
(39.322039, -91.541742) Vandalia, MO

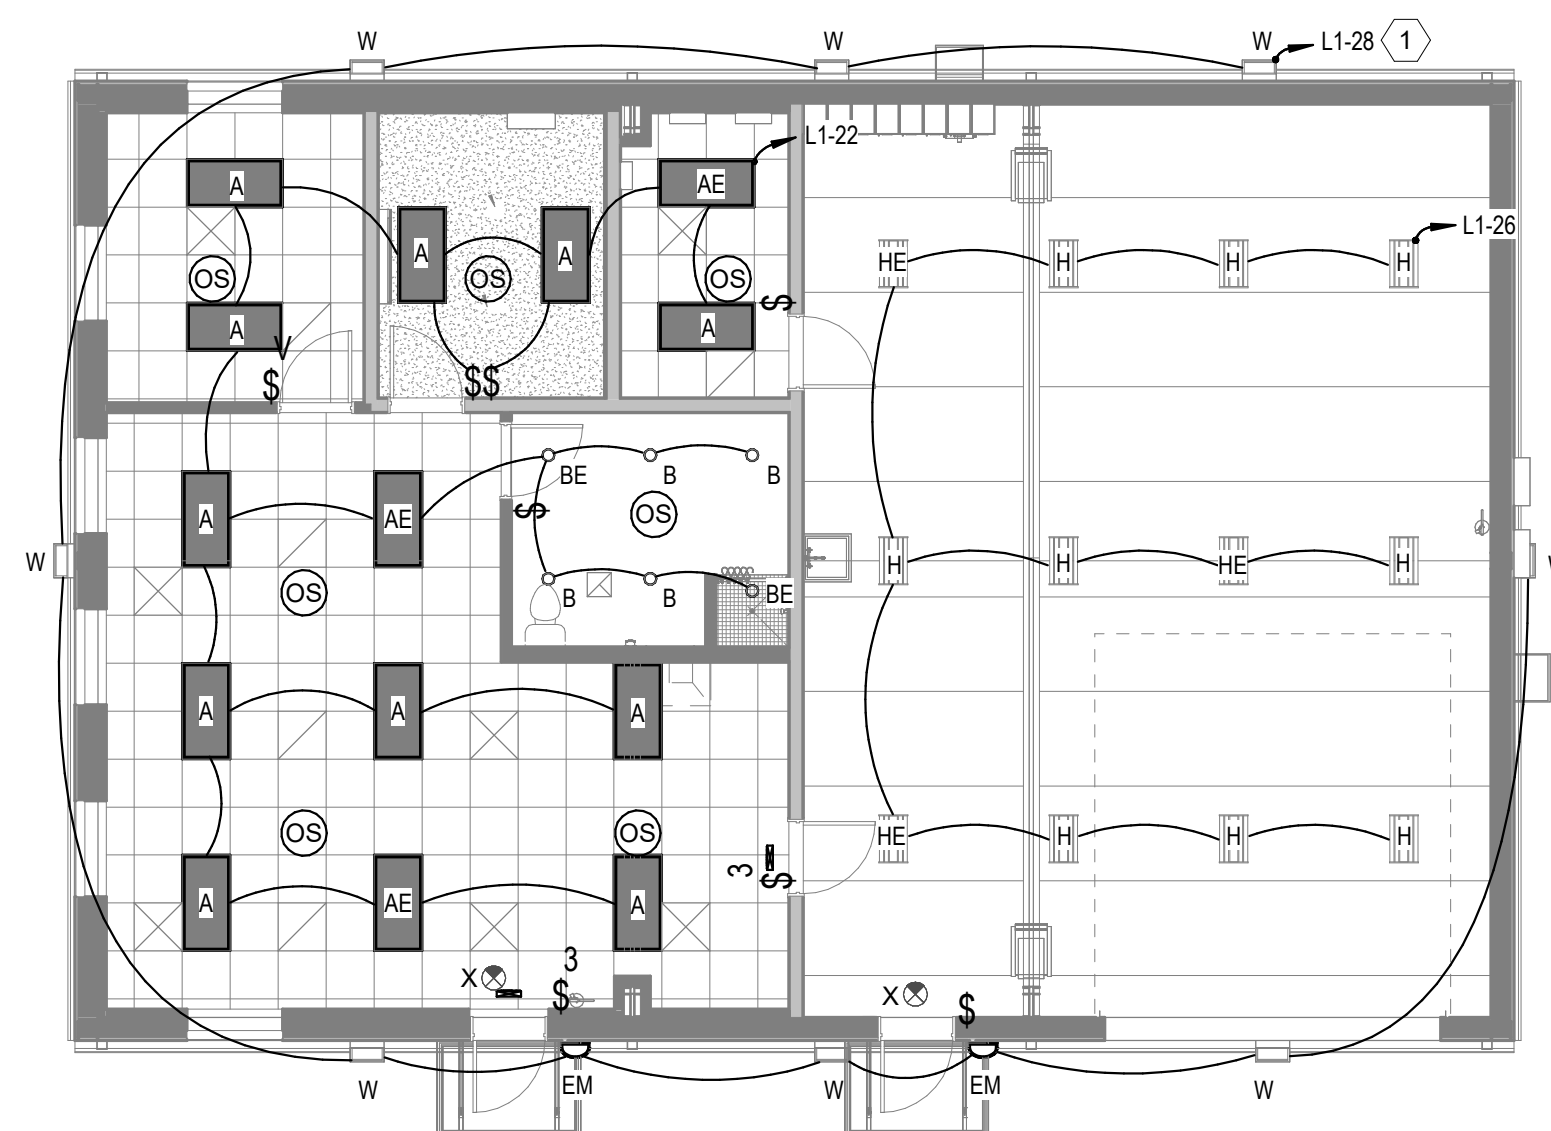


1 LIGHTING PLAN
1/8" = 1'-0"

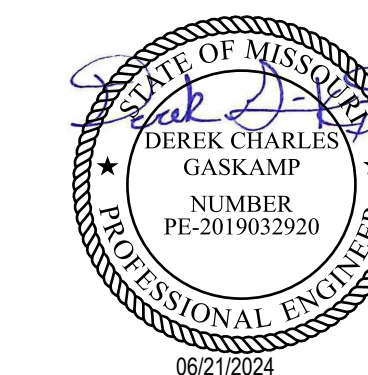

Copyright 2022
MBA Energy & Industrial
Drawings and Specifications are instruments of service and shall remain the property of MBA Energy & Industrial. They are not to be used on other projects or extensions to this project except by agreement in writing and with appropriate compensation to MBA Energy & Industrial.

Sheet Content:
LIGHTING PLAN


SCALE: 1/8" = 1'-0"

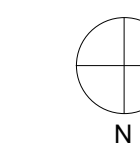

Drawn By:
Checked By:
Plot Date: 01/29/2024
Project Number: H23233

Sheet:

E3.01

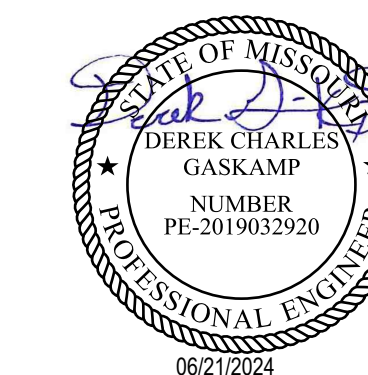


Copyright 2022
MBA Energy & Industrial
Drawings and Specifications are instruments of service and shall remain the property of MBA Energy & Industrial. They are not to be used on other projects or extensions to this project except by agreement in writing and with appropriate compensation to MBA Energy & Industrial.

Sheet Content:
ELECTRICAL DETAILS

SCALE: NOT TO SCALE

Drawn By:
Checked By:
Plot Date: 01/29/2024
Project Number: H23233


Sheet:

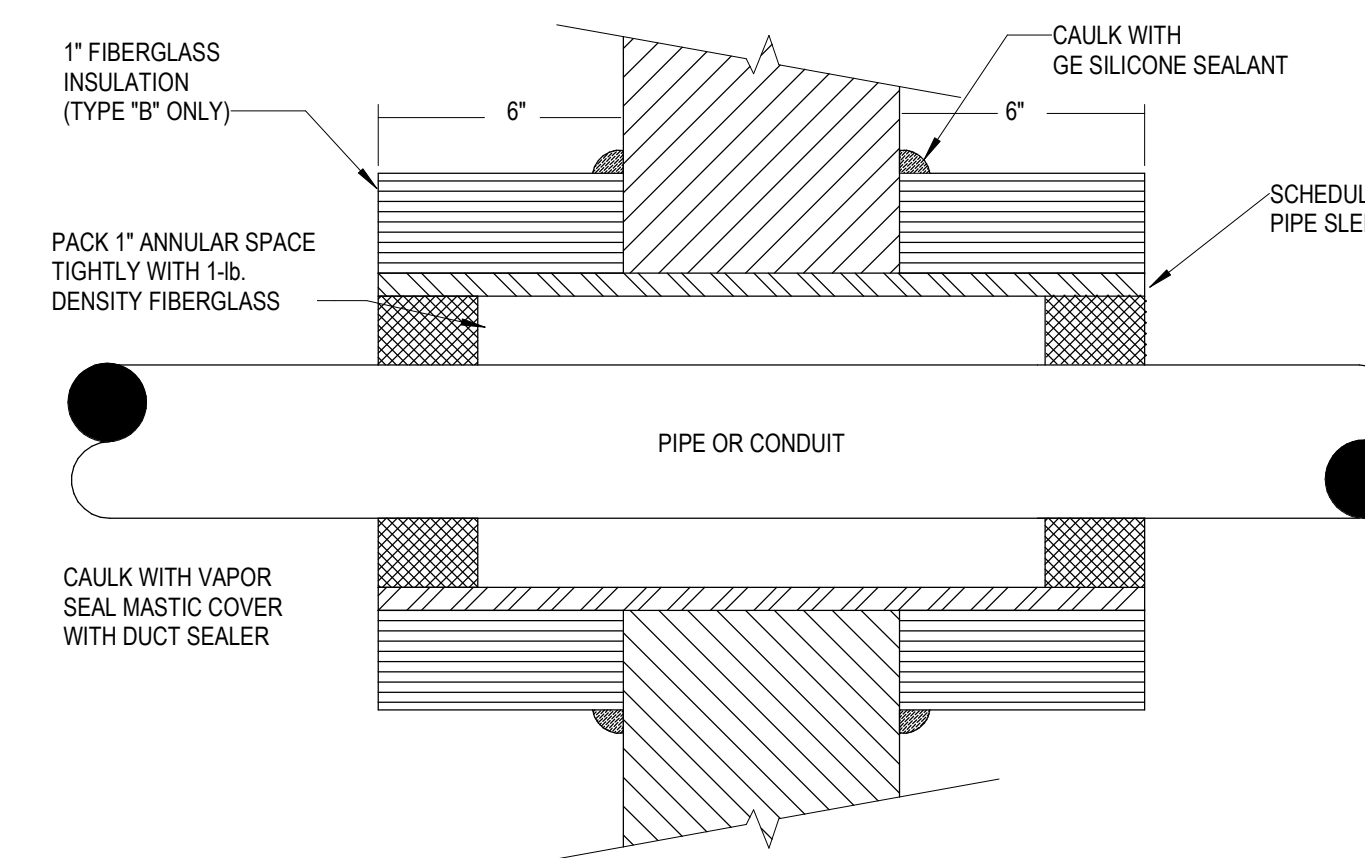


NOTES:

1. TYPICAL TREATMENT FOR CONDUIT AND H.V.A.C. PIPING FOR NON-FIRE-RATED WALLS.
2. SIZE SLEEVE TO ACCEPT CONDUIT.
3. FOR FIRE WALLS PROVIDE U.L. APPROVED SEAL ASSEMBLY FOR OPENING SIZE AND WALL TYPE.


3 CONDUIT SEALANT THRU WALLS
NOT TO SCALE

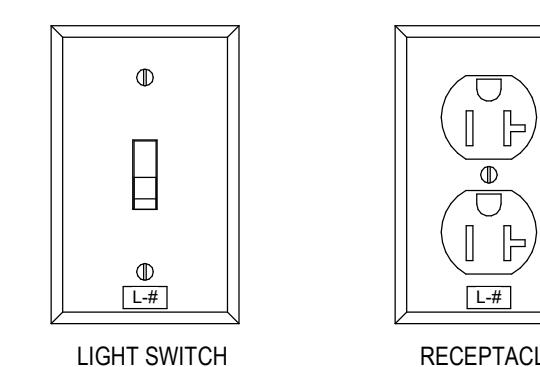

2 DEVICE PLATES - CIRCUIT LABEL
NOT TO SCALE

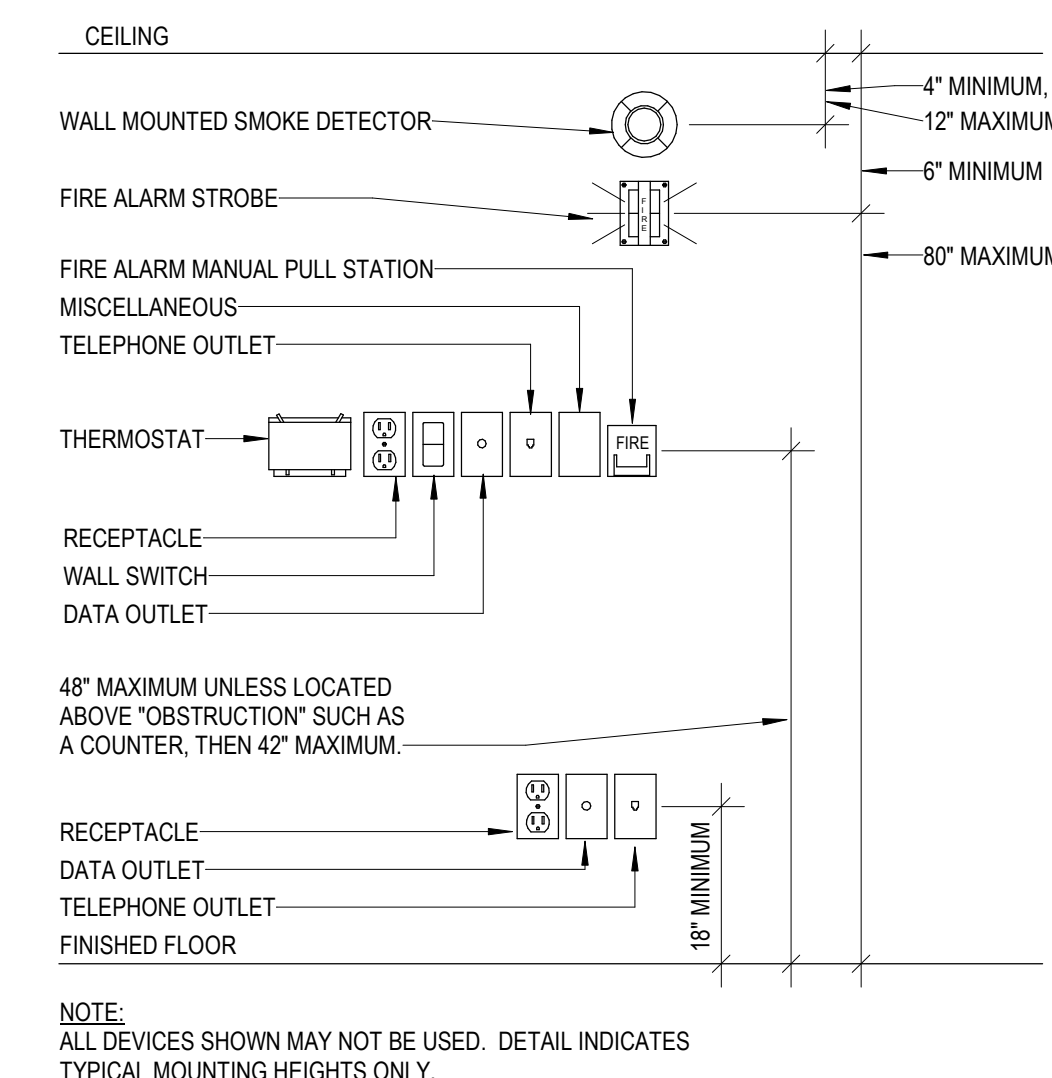

1 MOUNTING HEIGHT DETAIL
NOT TO SCALE

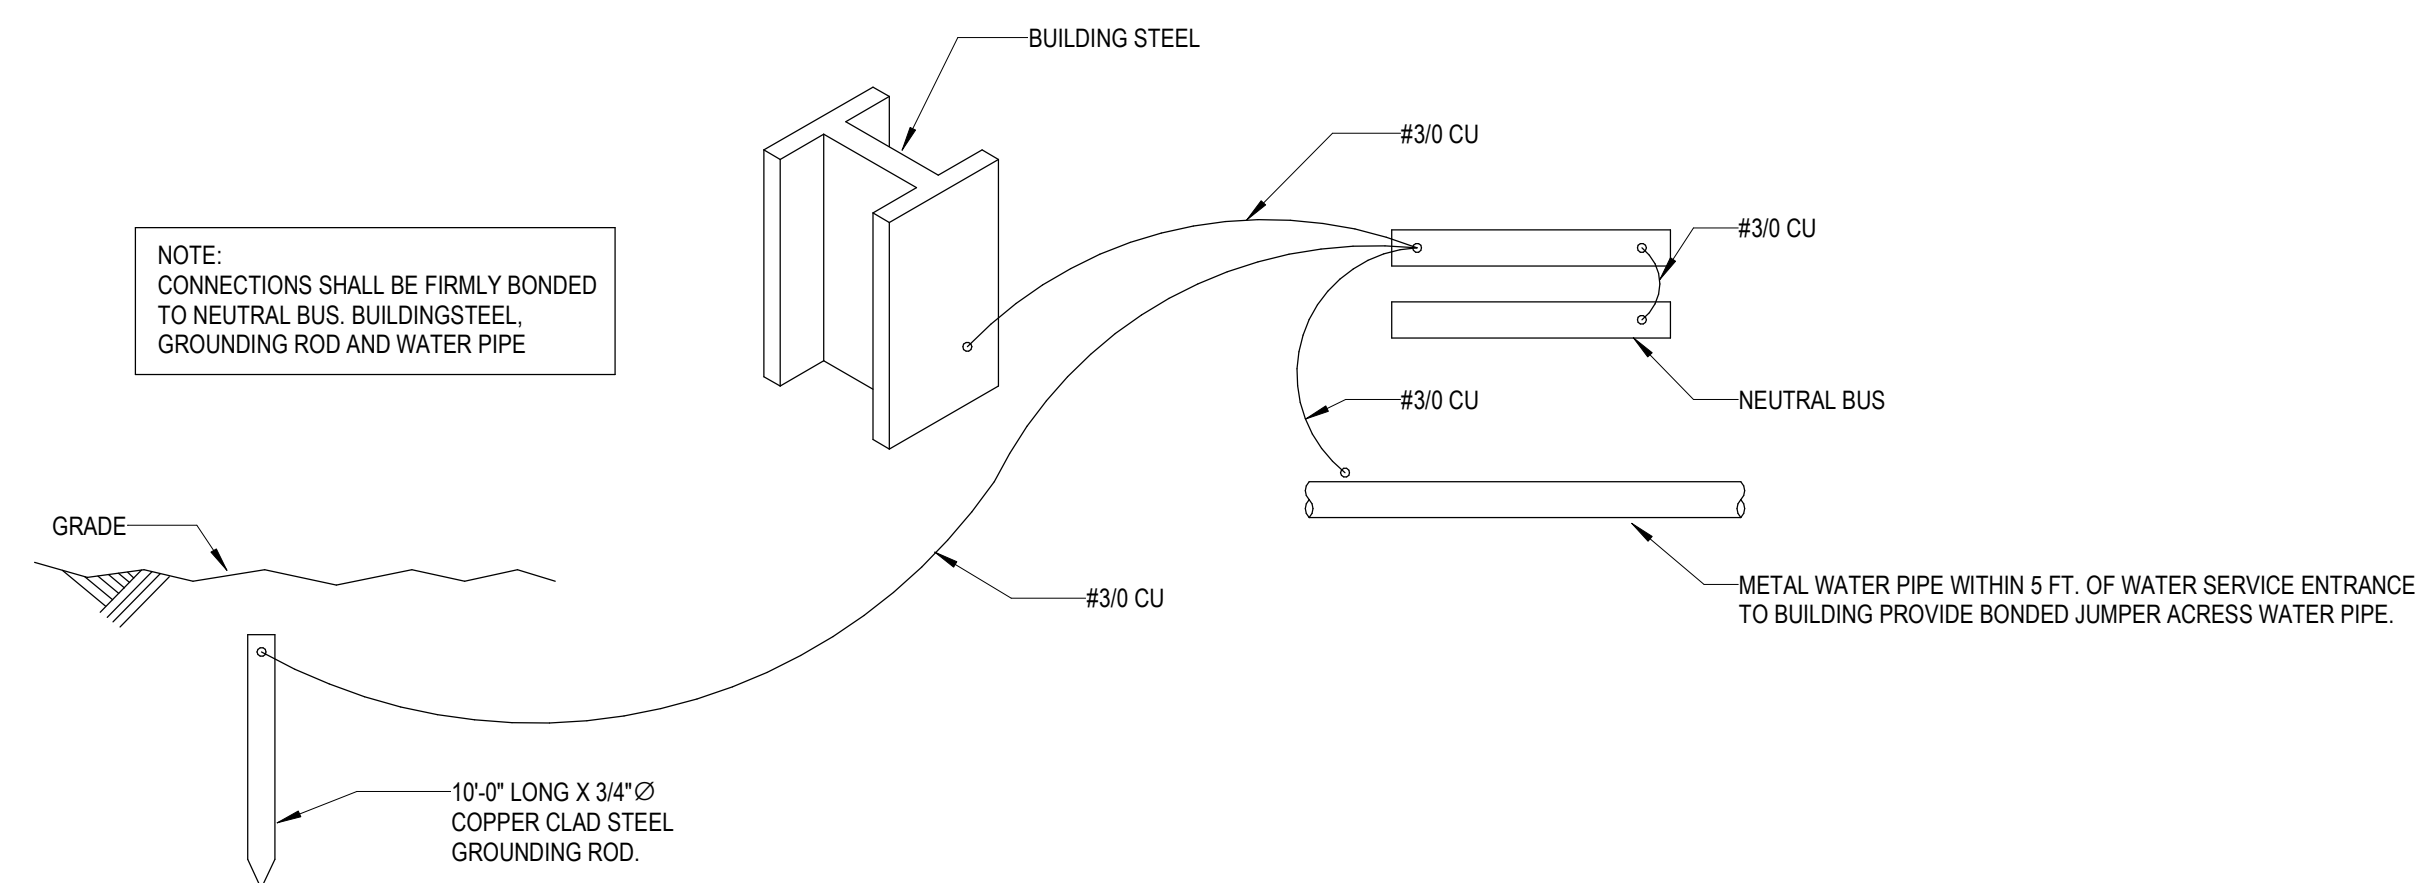

NOTE:
CONNECTIONS SHALL BE FIRMLY BONDED
TO NEUTRAL BUS, BUILDING STEEL,
GROUNDING ROD AND WATER PIPE

4 GROUNDING SYSTEM DETAIL
NOT TO SCALE

GENERAL NOTES

A ALL NEW WIRES SHALL HAVE THHN/THWN INSULATION.

KEYNOTE	DESCRIPTION
1	3/4" X 10'-0" COPPERCLAD GROUND ROD WITH #10 COPPER GROUNDING ELECTRODE CONDUCTOR CONNECTED TO GROUND LOOP. PROVIDE ADDITIONAL SUPPLEMENTAL GROUND ROD NO LESS THAN 6FT FROM FIRST GROUND ROD.
2	PROVIDE PERMANENTLY AFFIXED FAULT CURRENT LABEL FOR ELECTRICAL EQUIPMENT AS REQUIRED BY NEC 110.24. LABEL SHALL BE A 2"X3" RECTANGLE WITH BLUE LETTERING ON A CONTRASTING BACKGROUND SHOWING THE DATE AND CURRENT RATING AT THE TIME OF CALCULATION.



Date Issued:
02/23/24
06/26/24


Issue for Construction
IFC Set Addendum 02



10200 Westheimer Road., Suite 400
Houston, TX 77042
713-429-4949
www.InfinityMEP.com

**HUCK FINN SOLAR
OPERATIONS & MAINTENANCE BUILDING**

Project Address:
(39.322039, -91.541742) Vandalia, MO

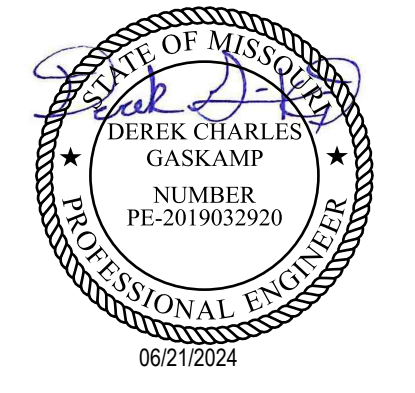

Copyright 2022
MBA Energy & Industrial
Drawings and Specifications are instruments of service and shall remain the property of MBA Energy & Industrial. They are not to be used on other projects or extensions to this project except by agreement in writing and with appropriate compensation to MBA Energy & Industrial.

Sheet Content:
PANEL SCHEDULES & RISER

SCALE: As indicated


Drawn By:
Checked By:
Plot Date: 01/29/2024
Project Number: H23233

Sheet:

E7.00

NEW												L1												PANELBOARD											
FULL SIZE NEUTRAL, W/ COPPER GROUND BUS												400 AMP MCB												400 AMP BUS RATING											
1 NEMA ENCLOSURE												240 VOLT P-P																							
X FEED THRU LUGS												120 VOLT P-N																							
SURFACE MOUNTING												1 PHASE																							
												3 WIRE																							
												22000 AIC SYMMETRICAL																							
C PH	B PH	A PH	LOAD	TYPE	DESCRIPTION	CKT BKR	NO	NO	NO	CKT BKR	DESCRIPTION	TYPE	LOAD	A PH	B PH	C PH																			
(AMP)	(AMP)	(AMP)	(VA)			AMP	IP			AMP	IP		(VA)	(AMP)	(AMP)	(AMP)																			
8.3		8.0	720	RP	4 DUPLEX	20 /1	1	A	2	30 /2	SPD																								
			2000	RP	IT L6-20R	20 /2	3	C	4																										
		8.3		RP		5	A	6	20 /2	IT L6-20R	RP	2000	8.3																						
8.3		1000		RP	IT QUAD	20 /1	7	C	8							8.3																			
		8.3	1000	RP	IT DUPLEX	20 /1	9	A	10	20 /1	DISHWASHER	RP	1000	8.3																					
4.5		540		RP	3 DUPLEX	20 /1	11	C	12	20 /1	MICROWAVE	RP	1000			8.3																			
		1800		RP	5 QUAD	20 /1	13	A	14	50 /2	OVEN	MN	6000	25.0		25.0																			
4.5		540		RP	WAREHOUSE DUPLEX	20 /1	15	C	16			MN																							
		4.2	500	MN	FACP	20 /1	17	A	18	20 /1	REFRIGERATOR	RP	1000	8.3																					
2.9		896		C	FCU-3	15 /2	19	C	20	20 /1	HOOD VENT	RP	1000			8.3																			
		2.9		C		24	A	20	20 /1	LIGHTING	LT	778	6.5																						
29.1		6984		C	HP-2	35 /2	23	C	24		SPACE																								
		29.1		C		25	A	26	20 /1	WAREHOUSE LIGHTING	LT	1212	10.1																						
				C	SPACE	27	C	28	20 /1	OUTDOOR LIGHTING	OL	329				2.7																			
29.1		6984		C	HP-1	35 /2	31	C	32		IT L6-20R	RP	2000	8.3																					
		29.1		C		33	A	34		SPACE						8.3																			
2.9		696		C	FCU-1	15 /2	35	C	36	20 /1	EF-2.3	MN	900			7.5																			
		2.9		C		37	A	38	20 /1	FIRE/SMOKE DAMPERS	MN	500	4.2																						
13.4		3216		C	FCU-2/FCU-1	20 /2	39	C	40	20 /2	IT L6-20R	RP	2000			8.3																			
		13.4		C		41	A	42		SPACE						8.3																			

NEW												L2												PANELBOARD											
FULL SIZE NEUTRAL, W/ COPPER GROUND BUS												400 AMP MCB												400 AMP BUS RATING											
1 NEMA ENCLOSURE												240 VOLT P-P																							
SURFACE MOUNTING												120 VOLT P-N																							
												1 PHASE																							
												3 WIRE																							
												22000 AIC SYMMETRICAL																							
C PH	B PH	A PH	LOAD	TYPE	DESCRIPTION	CKT BKR	NO	NO	NO	CKT BKR	DESCRIPTION	TYPE	LOAD	A PH	B PH	C PH																			
(AMP)	(AMP)	(AMP)	(VA)			AMP	IP			AMP	IP		(VA)	(AMP)	(AMP)	(AMP)																			
8.3		6.0	720	RP	OUTDOOR RECEPTACLES	20 /1	1	A	2	20 /1	CP-1	MN	400	3.3																					
			1000	MN	OVERHEAD DOOR	20 /1	3	C	4	30 /2	EW-H1	MN	4500			18.8																			
				MN	MOTOR PUMP	20 /1	5	A	6			MN				18.8																			
8.3				MN	RECEPTACLES	20 /1	7	C	8	50 /2	WELDING RECEPTACLE	MN	7200	30.0		30.0																			
				MN		10	A	10				MN				30.0																			
					SPACE	11	C	12	50 /2	EV CHARGER	MN	7680	32.0			32.0																			
					SPACE	13	A	14				MN	400			3.3																			
					SPACE	15	C	16				MN	4500			18.8																			
					SPACE	17	A	18				MN				18.8																			
					SPACE	19	C	20				MN				32.0																			
					SPACE	21	A	22				MN				32.0																			
					SPACE	23	C	24				MN				32.0																			
					SPACE	25	A	26				MN				32.0																			
					SPACE	27	C	28				MN				32.0																			
					SPACE	29	A	30				MN				32.0																			
					SPACE	31	C	32				MN				32.0																			
					SPACE	33	A	34				MN				32.0																			
					SPACE	35	C	36				MN				32.0																			
					SPACE	37	A	38				MN				32.0																			
					SPACE	39	C	40				MN				32.0																			
					SPACE	41	A	42				MN				32.0																			

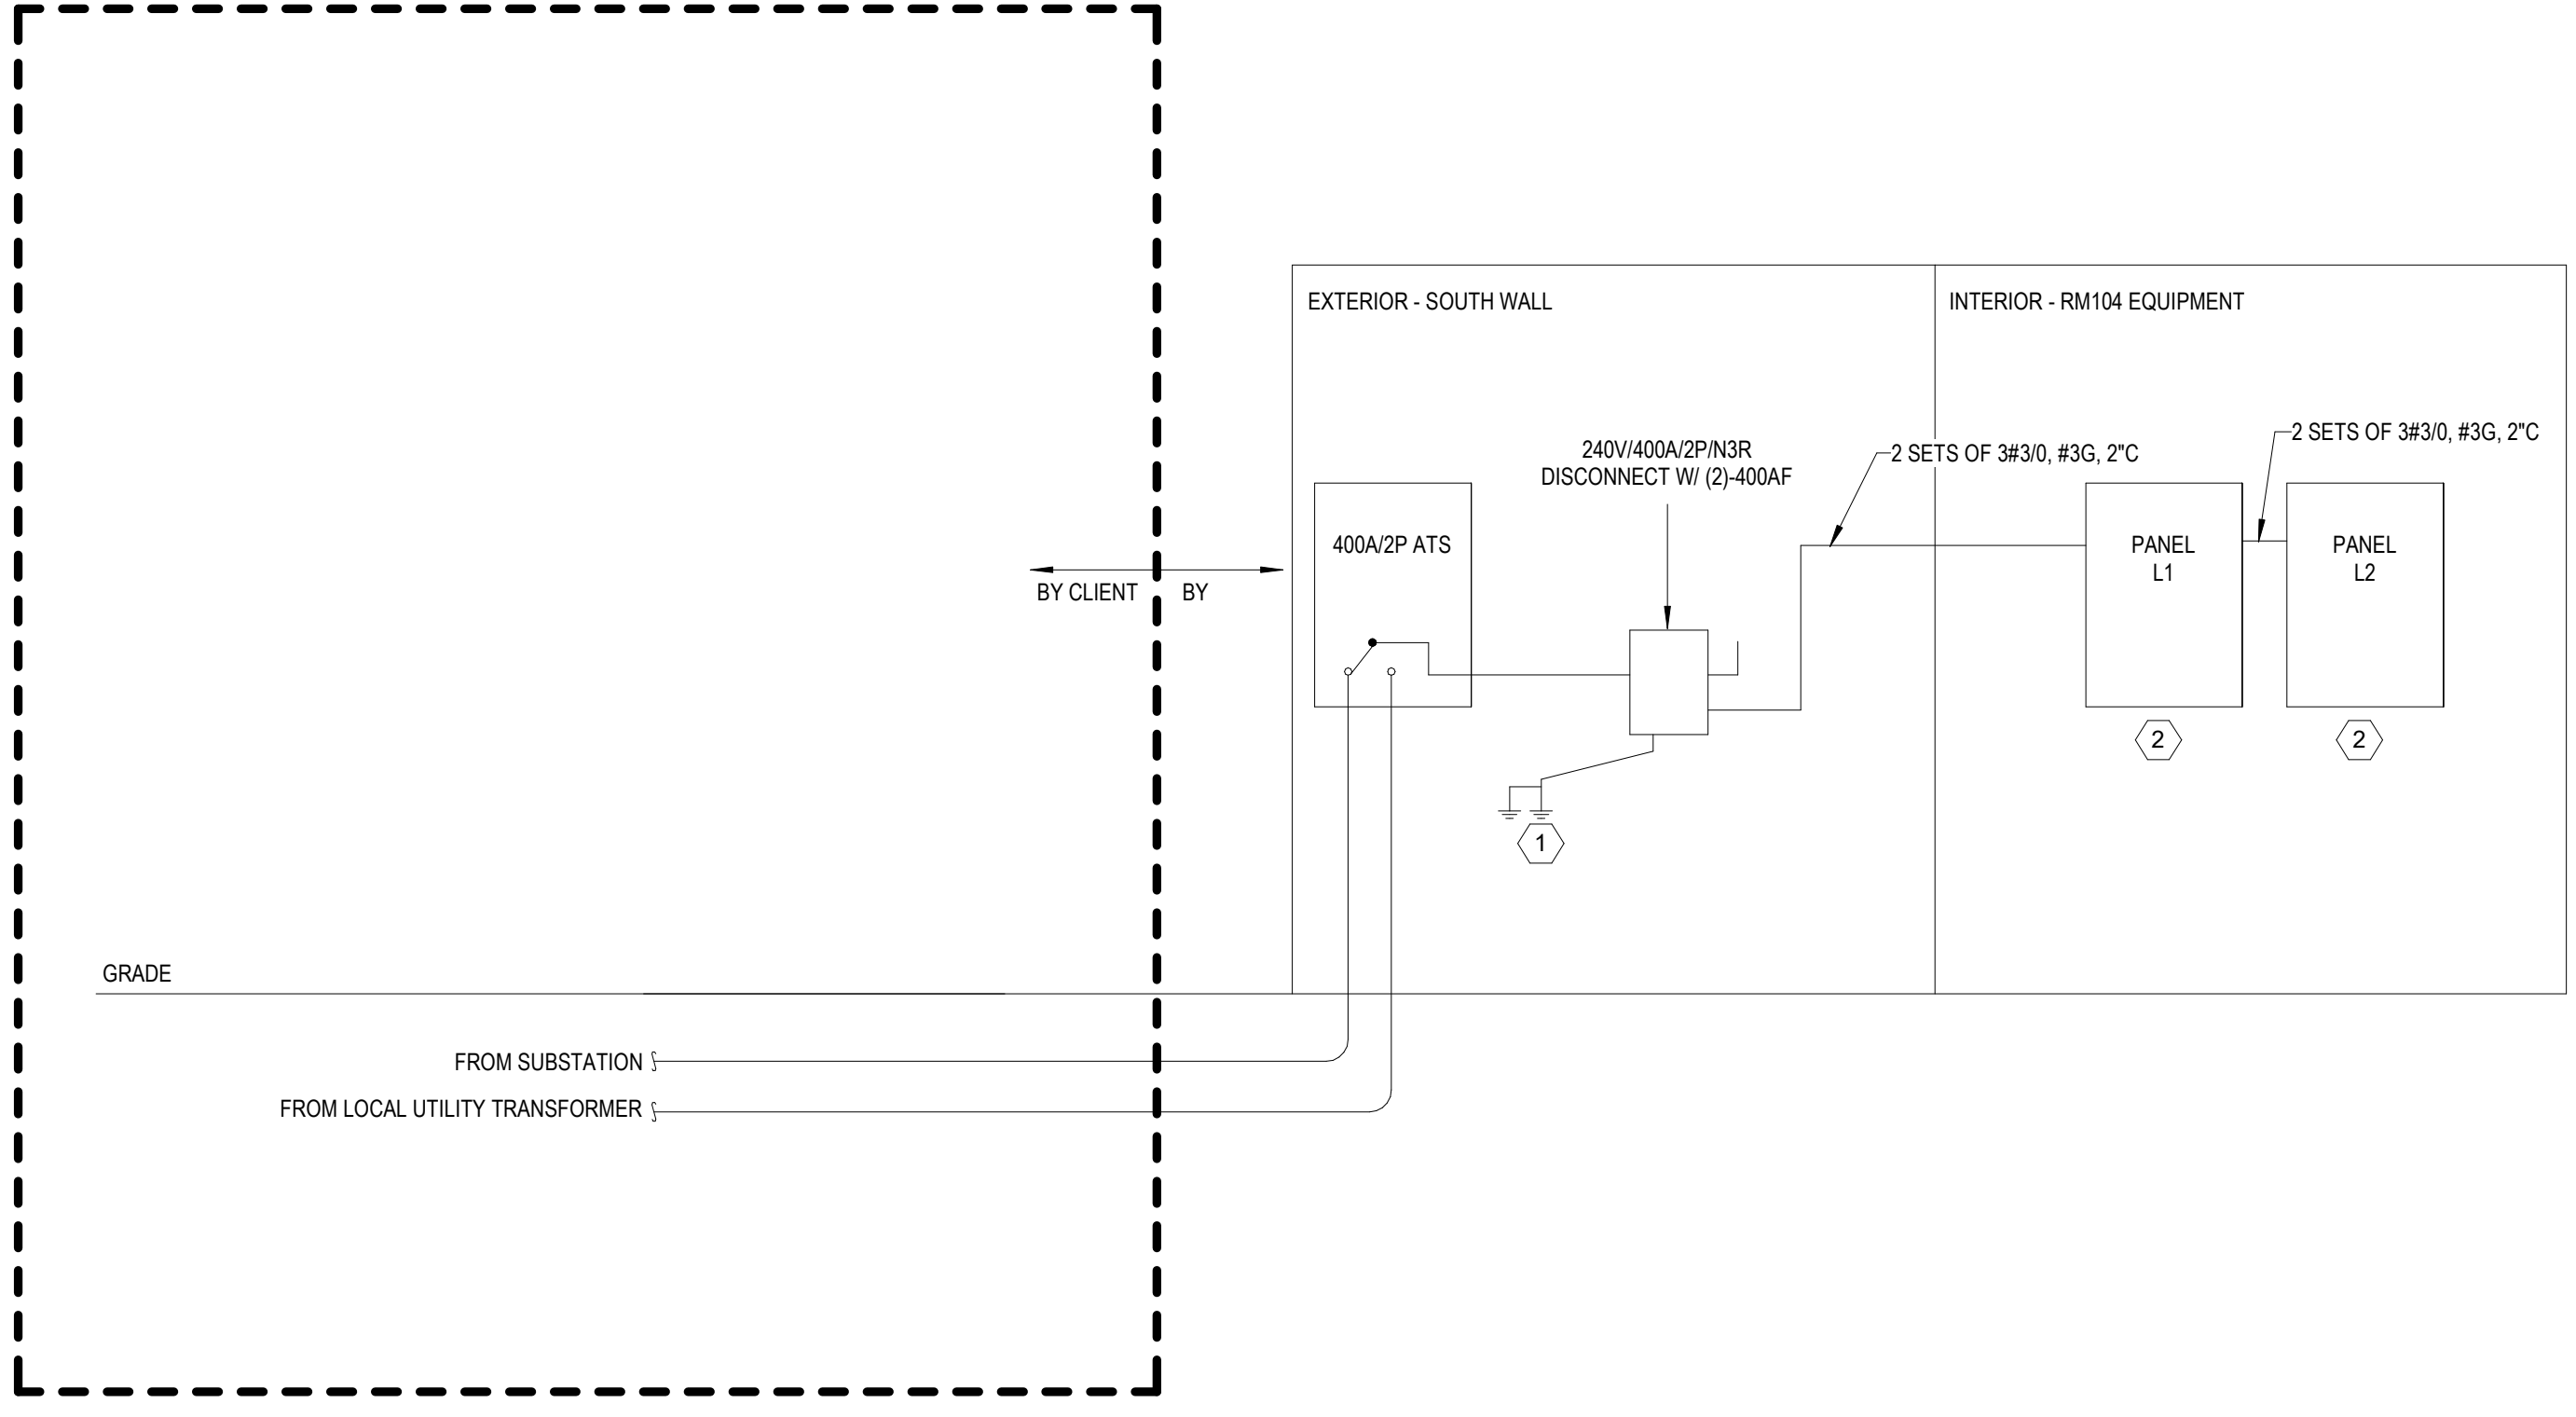

1 ELECTRICAL RISER DIAGRAM
NOT TO SCALE